




PLAN
Scale 1:200

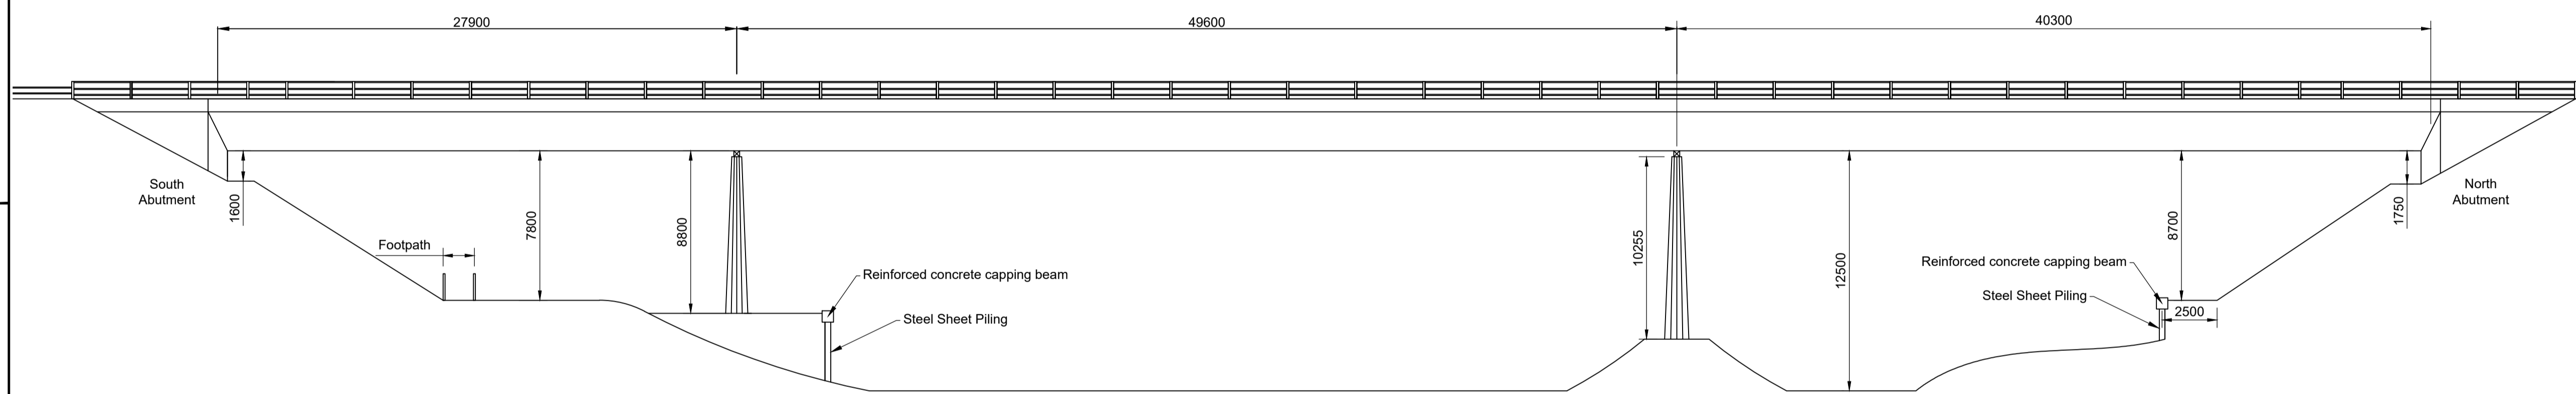

EAST ELEVATION
Scale 1:200

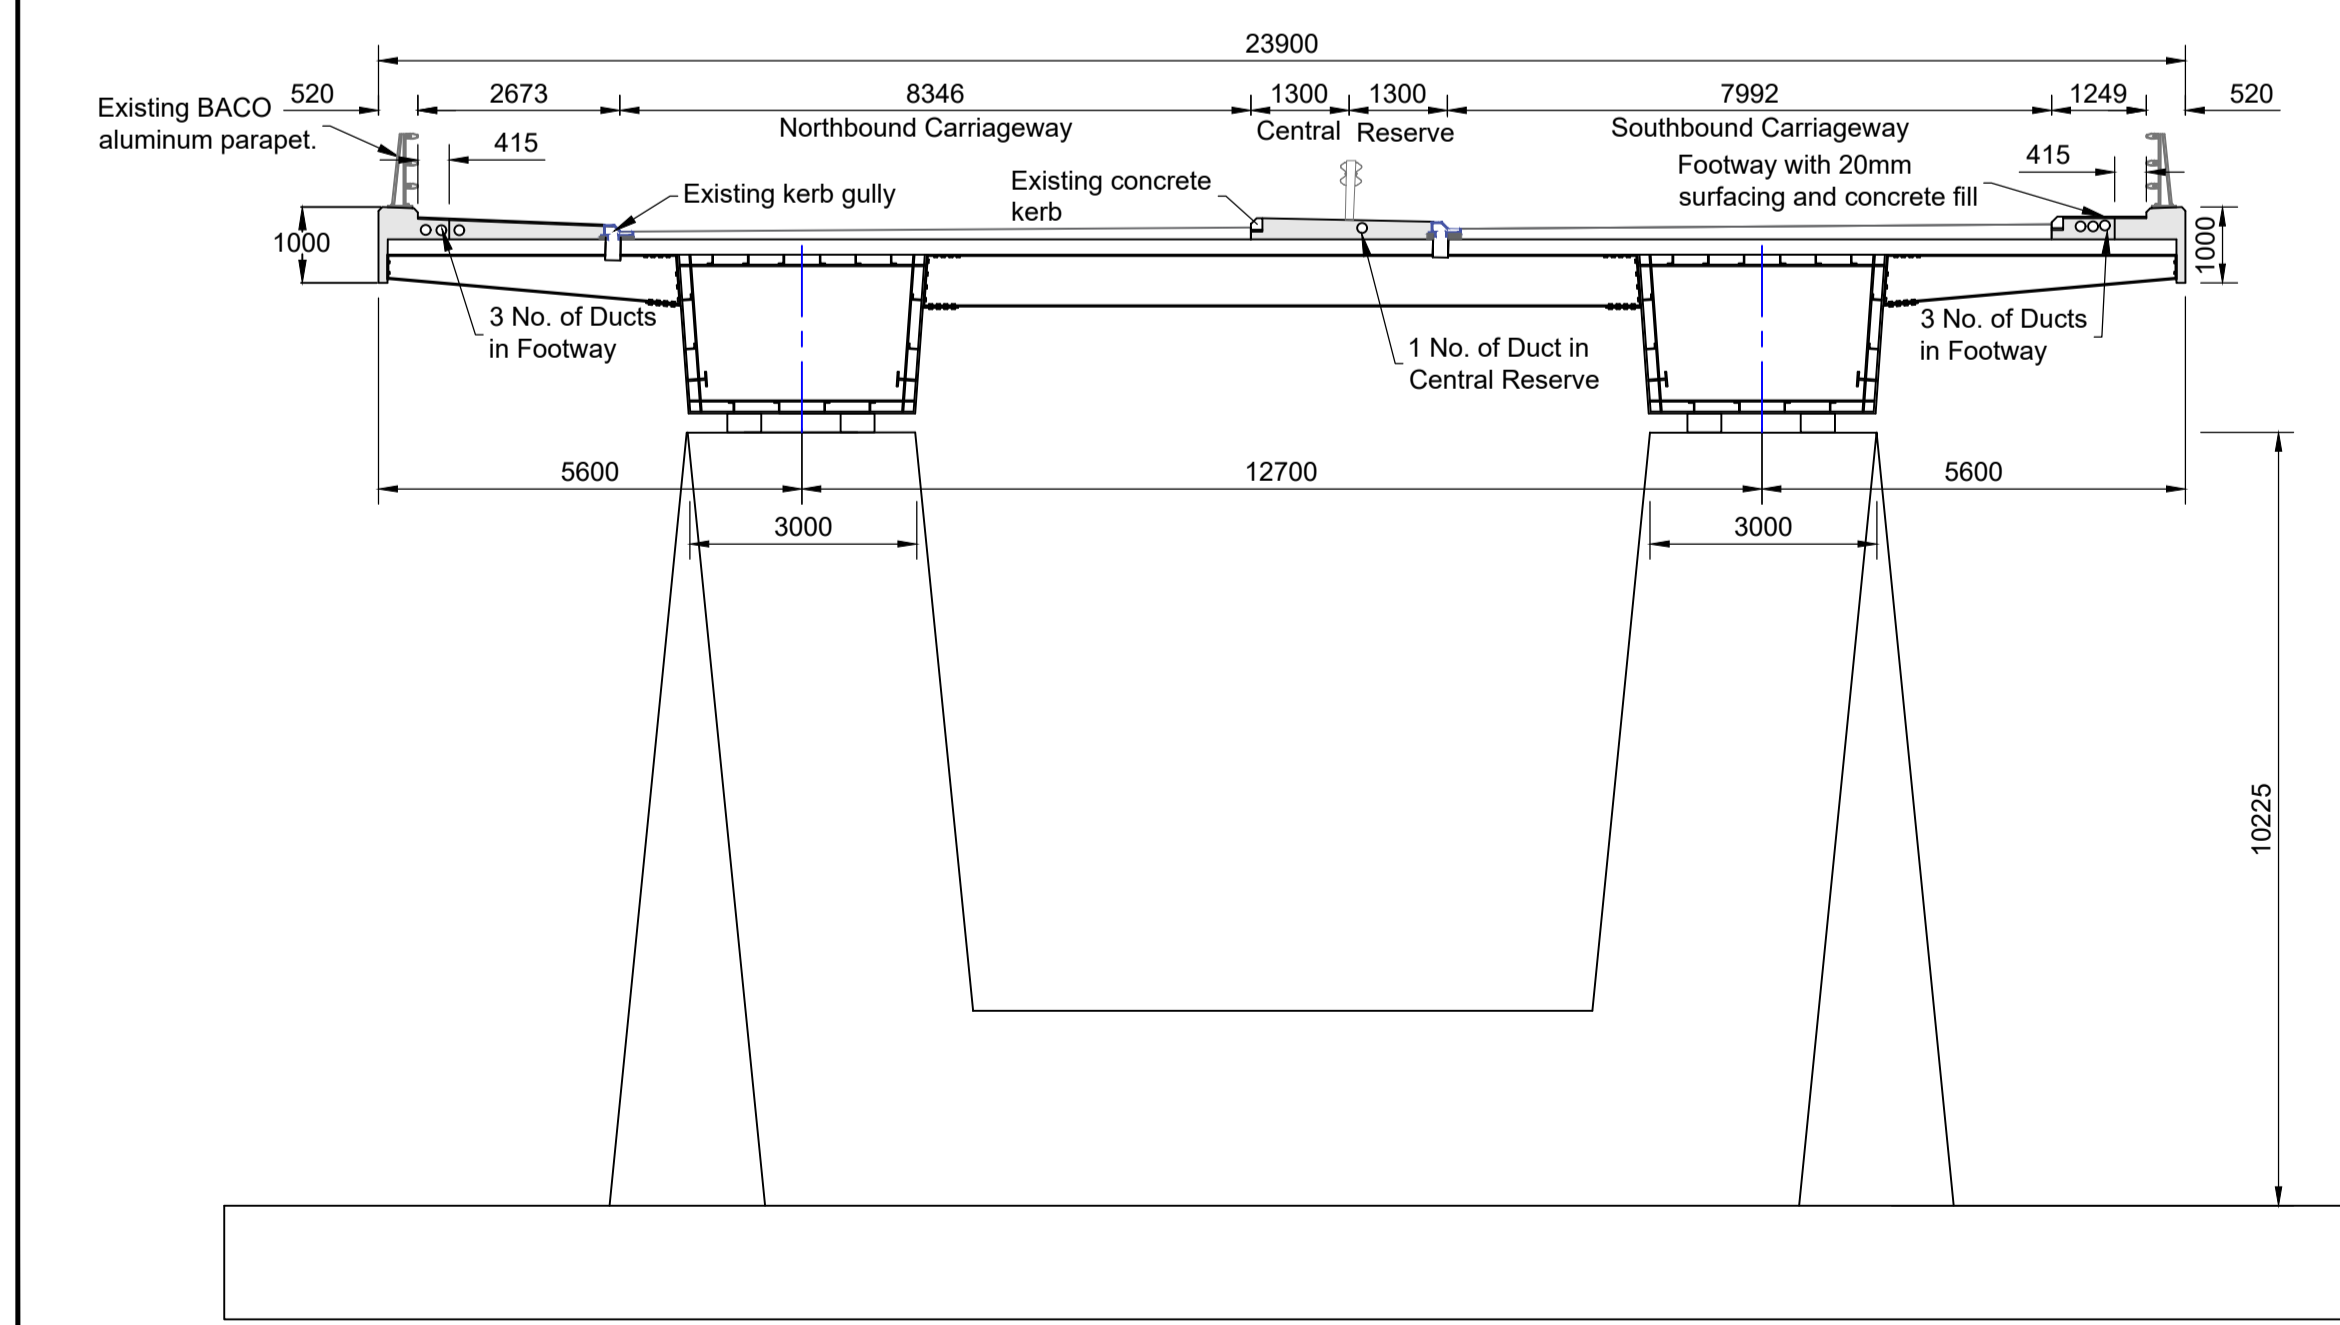

SECTION A-A
Scale 1:100

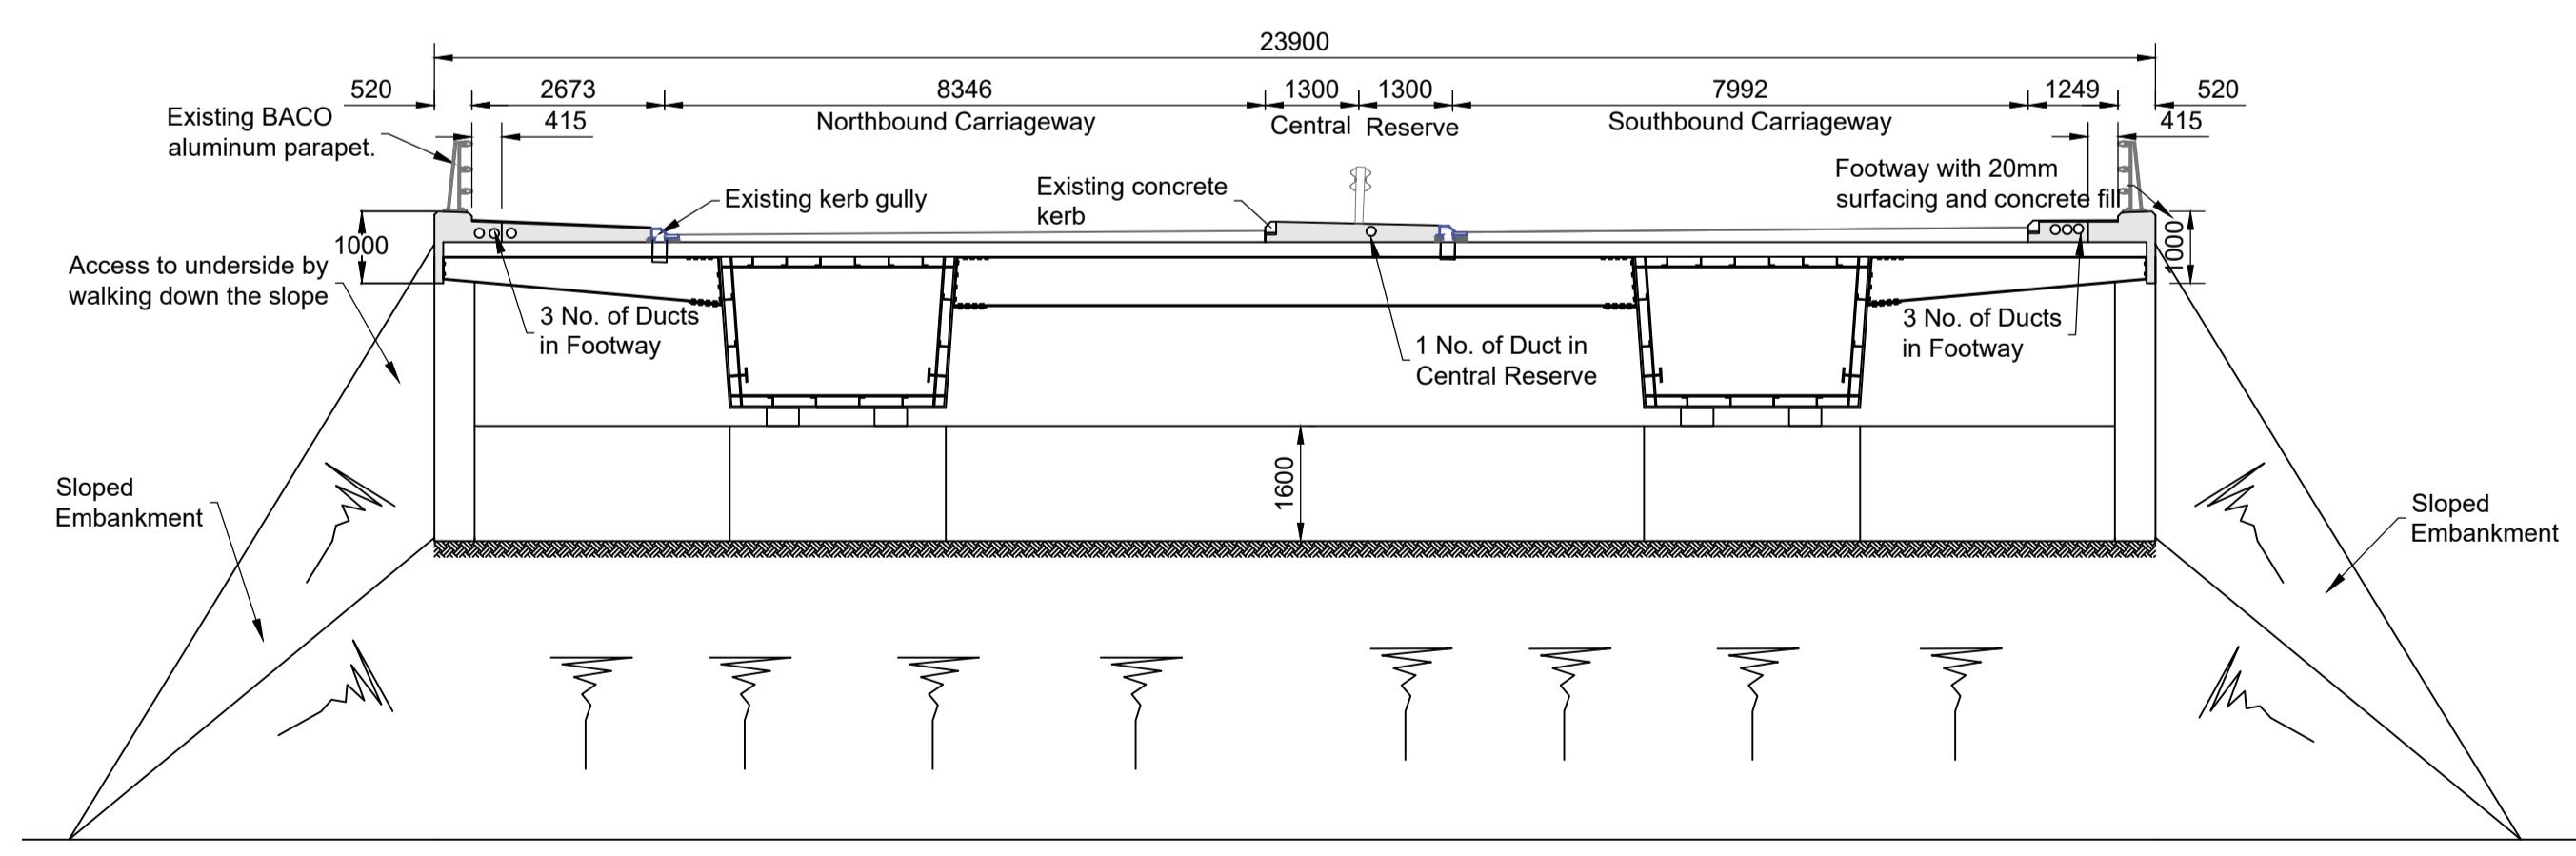

ELEVATION OF SOUTH ABUTMENT
Scale 1:100

RESIDUAL DESIGN HAZARDS
(The following information has been collected from Preconstruction Information and the Amey CDM Hazard Management Process.)

- Working adjacent to or above river earn
- Working adjacent to or below a live carriageway
- Working on steep embankments and soft ground
- Presence of buried lost or unrecorded services

- NOTES**
- All dimensions in millimetres unless otherwise stated.
 - Do not scale from this drawing, use written dimensions and print in colour.
 - Dimensions recorded on this drawing were extracted from As-Built drawings and have not been validated on-site.

KEY

- FOUL - Scottish Water foul line
- Existing aluminum parapet to be removed
- Footway and central reserve
- Grassed verge

DRAFT

Rev	Text	Drwn	Chkd	Appd	Date
P01.1	Text				
	Revision details				

Designed: T. Boyapati Date: 18/03/2025
 Drawn: T. Boyapati Date: 22/04/2025
 Snr Tech Check: . Date: .
 Checked: . Date: .
 Approved: A. Njie Date: .

Copyright in this design © Amey

Amey
www.amey.co.uk

Client
TRANSPORT SCOTLAND
CONVEYANCE

Project Name
M90 9-10 25
Earn - Deck Refurbishment and Concrete Repairs

Drawing Title
Series 0100: Preliminaries

General Arrangement Drawing - Sheet 3 of 3

Original Drawing Size : A1	Scale : As Shown
Dimensions : -	

Drawing Status For Information	Suitability S0
--	-------------------

Drawing No 24-NE-1201-026-M90-25-0100-03	Rev P01.1
--	--------------