

SEABED PROFILE


-EXISTING SEABED (SOFT)

-PROPOSED DREDGE PROFILE

-5.0 DREDGE LEVEL

### LONG SECTION THROUGH WEST DREDGE SECTION A-A

SCALE 1:100

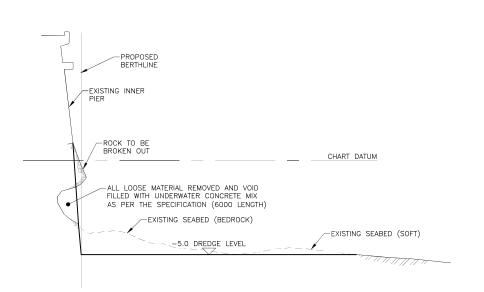

CROSS SECTION THROUGH INNER PIER/DREDGE SECTION B-B

SCALE 1:100


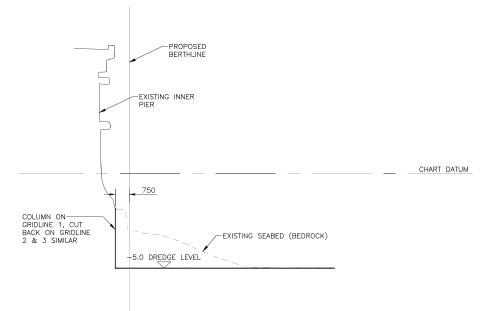



CHART DATUM

CROSS SECTION THROUGH MIDDLE PIER/DREDGE SECTION C-C

SCALE 1:100



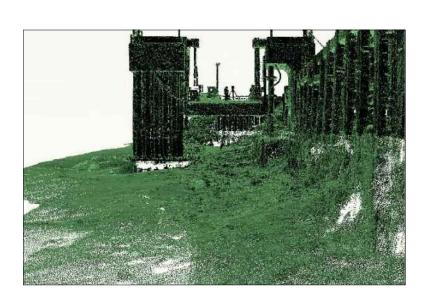

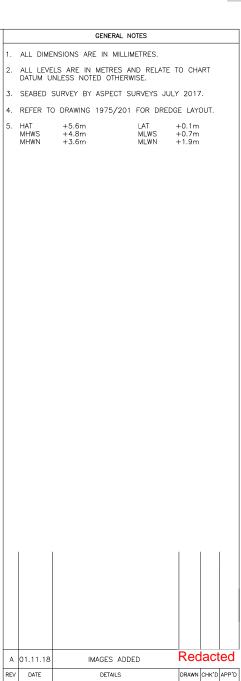




LOCHMADDY FERRY TERMINAL UPGRADE WORKS





PROPOSED INNER DREDGE SECTIONS

HEBRIDES 01851 612454 hebrides@wallacestone.co.uk

Redacted	CHECKED	APPROVED						
DATE	DATE	DATE						
MAY 2018	OCT. 2018	OCT. 2018						
SCALE (A1) AS SHOWN	STAGE_	ENDER						
REVISION A								
PROJECT No.	DRAWIN	IG No.						
1975	5	202						

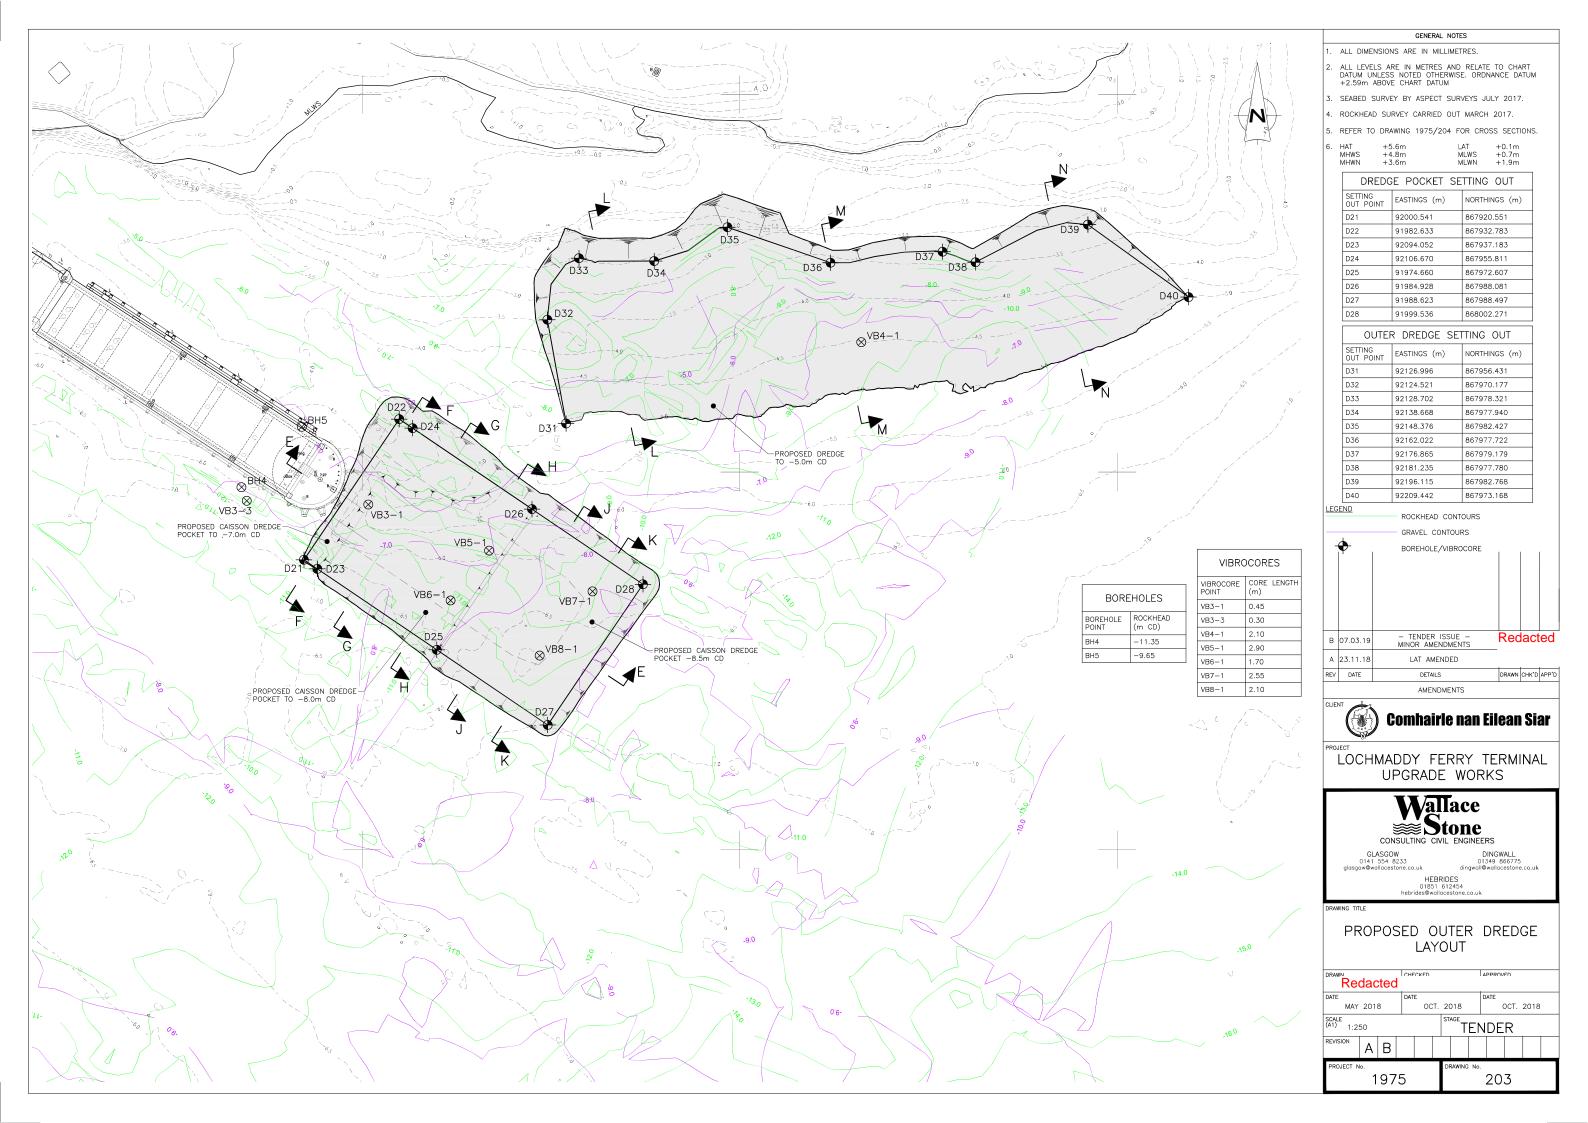


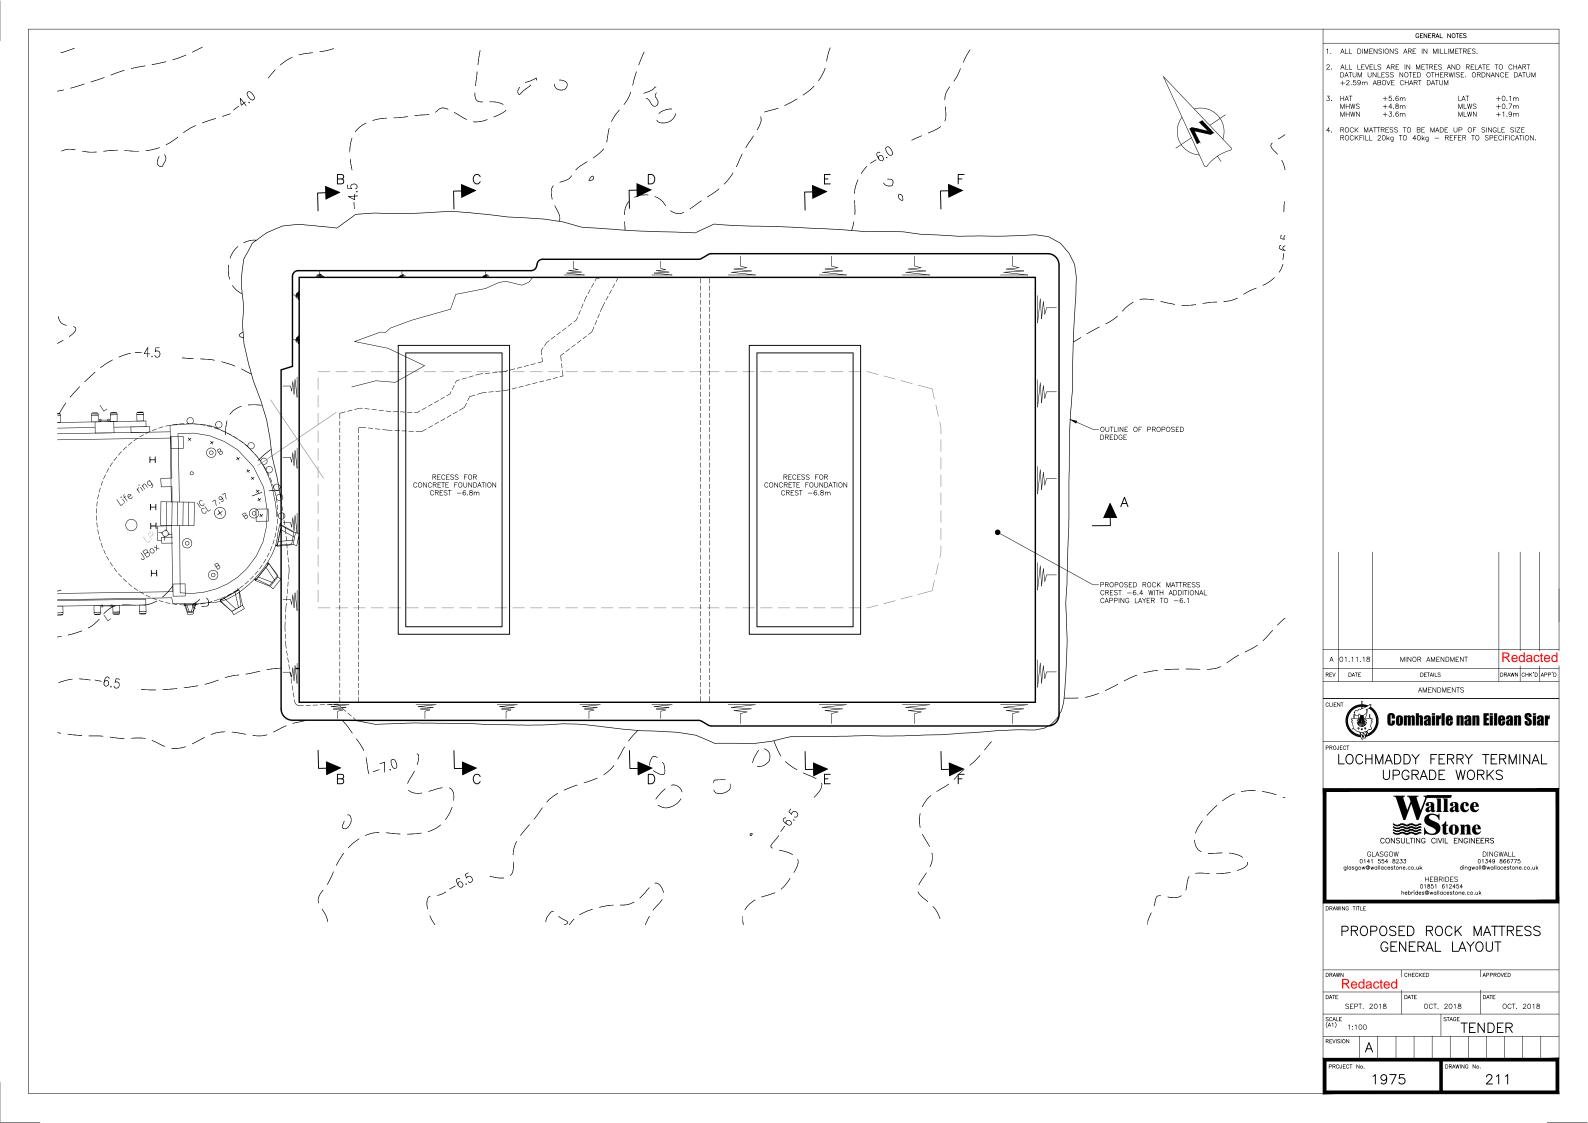

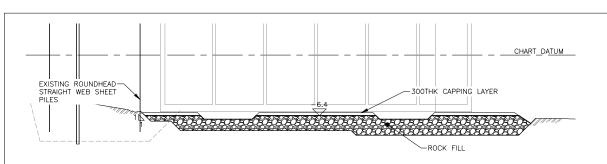


### LONG SECTION THROUGH CAISSON POCKET DREDGE SECTION A-A

SCALE 1:200

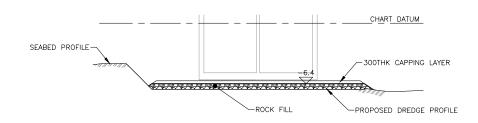


### CROSS SECTION THROUGH CAISSON POCKET DREDGE SECTION B-B

SCALE 1:200

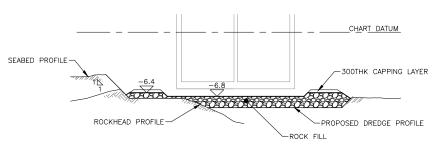


### CROSS SECTION THROUGH CAISSON POCKET DREDGE SECTION C-C

SCALE 1:200

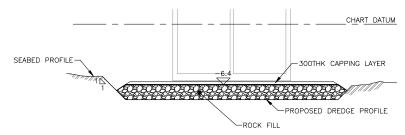


### CROSS SECTION THROUGH CAISSON POCKET DREDGE SECTION D-D

SCALE 1:200

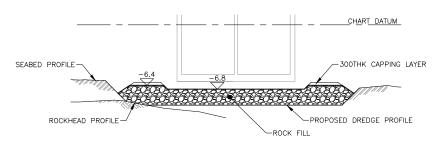

### CROSS SECTION THROUGH CAISSON POCKET DREDGE SECTION E-E

SCALE 1:200

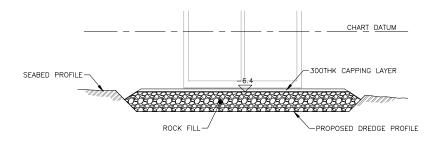

### CROSS SECTION THROUGH CAISSON POCKET DREDGE SECTION F-F

SCALE 1:200



GENERAL NOTES

LOCHMADDY FERRY TERMINAL


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HEBRIDES 01851 612454 hebrides@wallacestone.co.uk

PROPOSED ROCK MATTRESS SECTIONS

Rec	dac	ted	СНЕ	CKED		APPROVED							
ATE			DAT	E		DATE							
MAY	201	В		OCT. 2018				OCT. 2018					
CALE A1) 1:20			STAGE T	E١	NDE	:R							
REVISION	Α												
PROJECT N	lo.				1	DRAWING No.							
1975						212							



MHWS

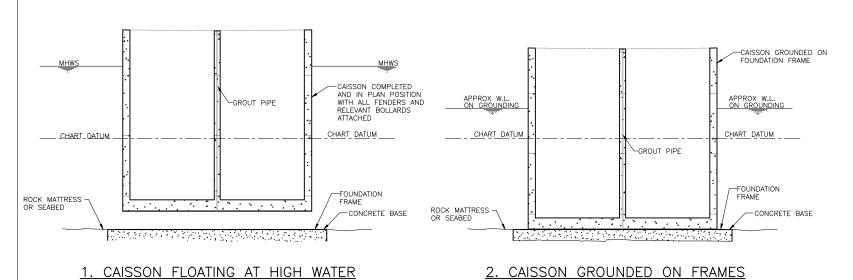CAISSON GROUNDED AND
FILLED WITH WATER TO PROVIDE
RESISTANCE TO FENDER LOADS
AND TO PREVENT RE-FLOTATION
ON RISING TIDE

MLWS

CHART DATUM

GROUT PIPE

FOUNDATION
FRAME
CONCRETE BASE

3. CAISSON FILLED WITH WATER ONCE AGROUND

GROUT PUMPED IN THROUGH PIPE

W.L.

MLWS

CHART DATUM

GROUT OPERATION — GROUT


200mm ABOVE TOP OF
FRAME

ROCK MATTRESS
OR SEABED

4. CAISSON GROUTED IN

**PLACE** 

SCALE 1:125

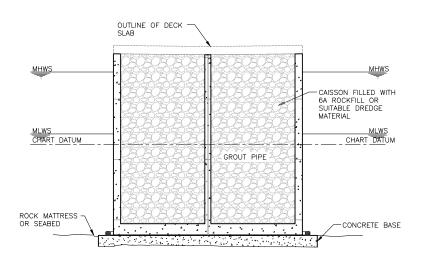


5. CAISSON FILLED WITH

ROCKFILL
SCALE 1:125

#### GENERAL NOTES

- 1. ALL LEVELS IN METRES RELATIVE TO CHART DATUM U.N.O.
- 2. ALL GROUT READER GW80.
- 3. ALL SILT SAND DEBRIS AND LAITANCE TO BE REMOVED FROM TOP SURFACE OF CONCRETE BASE PRIOR TO THE GROUNDING OF CAISSON.
- THE CAISSON SHALL NOT BE GROUNDED UNTIL THE CONCRETE BASE HAS ACHIEVED A STRENGTH OF 20N/mm².
- 5. CAISSON POSITIONING TO ACHIEVE TO THE FOLLOWING TOLERANCES:
  PLAN POSITION ±50mm
- 6. PROPOSALS FOR GROUNDING THE CAISSON TO BE PROVIDED BY THE CONTRACTOR. COMPREHENSIVE CALCULATIONS TO BE SUBMITTED TO PROVE STABILITY AND SAFETY OF METHOD.
- 7. FOR DETAILS OF FOUNDATION FRAMES REFER DRAWING 1975/223 & 224.
- 8. REFER TO SPECIFICATION FOR ROCK FILLING.

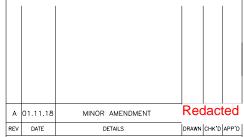

AMENDMENTS



LOCHMADDY FERRY TERMINAL UPGRADE WORKS




GLASGOW 0141 554 8233 lasgow@wallacestone.co.u


DINGWALL 01349 866775 dingwall@wallacestone.co.

HEBRIDES 01851 612454 hebrides@wallacestone.co.uk

DRAWING TITLE

### PROPOSED CAISSON INSTALLATION SEQUENCE

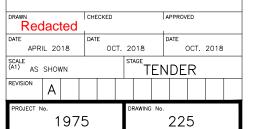

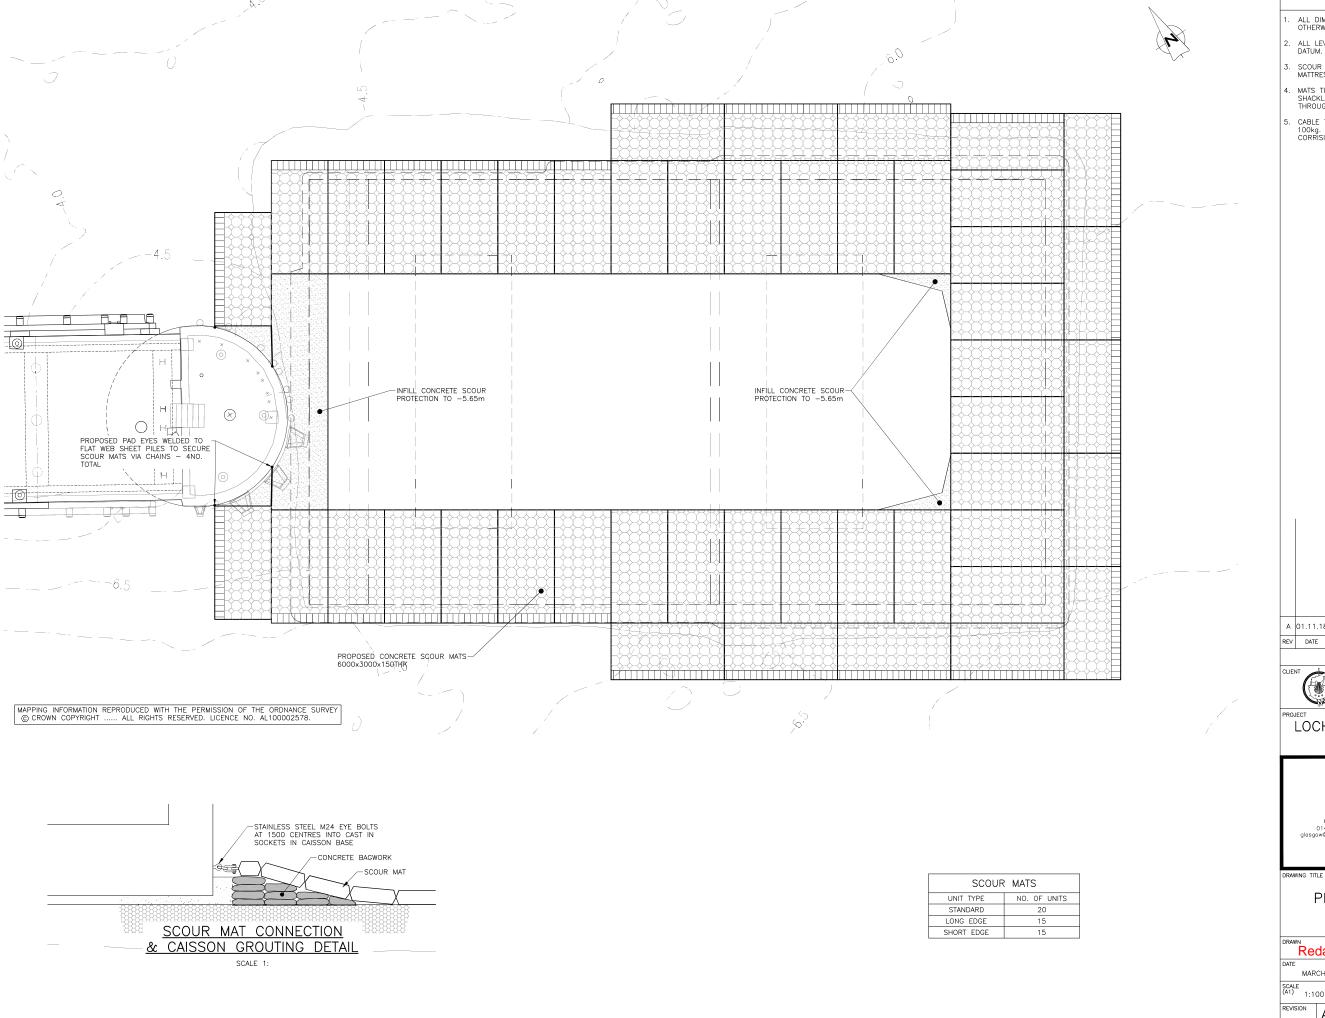

GENERAL NOTES

- ALL DIMENSINS ARE IN MILLIMETRES UNLESS NOTED OTHERWISE.
- 2. ALL LEVELS ARE IN METRES AND RELATE TO CHART DATUM.
- SCOUR MATS BY PIPESHIELD INTERNATIONAL LTD BLANKET MATTRESS.
- MATS TIED TOGETHER WITH GRADE 316 STAINLESS STEEL SHACKLES AT EACH CORNER AND NYLON CABLE TIES THROUGH ALL ADJOINING LOOPS BETWEEN CORNERS.
- CABLE TIES 12.5mm WITH MINIMUM TENSILE STRENGTH OF 100kg. SHACKLES SECURELY TIED WITH DURABLE CORRISION PROOF WIRE OR TIE.

MINOR AMENDMENTS Redacte DETAILS DRAWN CHK'D APP'D

AMENDMENTS




LOCHMADDY FERRY TERMINAL UPGRADE WORKS




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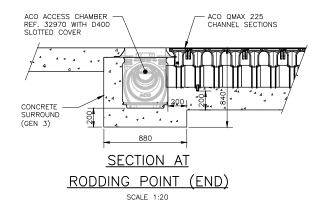
### PROPOSED SCOUR MAT **ARRANGEMENT**


Reda	CHECK	CHECKED				APPROVED							
DATE	DATE					DATE							
MARCH	OCT.			2018 0			OCT. 2018						
SCALE (A1) 1:100	SCALE (A1) 1:100						TENDER						
REVISION													
PROJECT No.	DF	RAWING	No.	22	7								



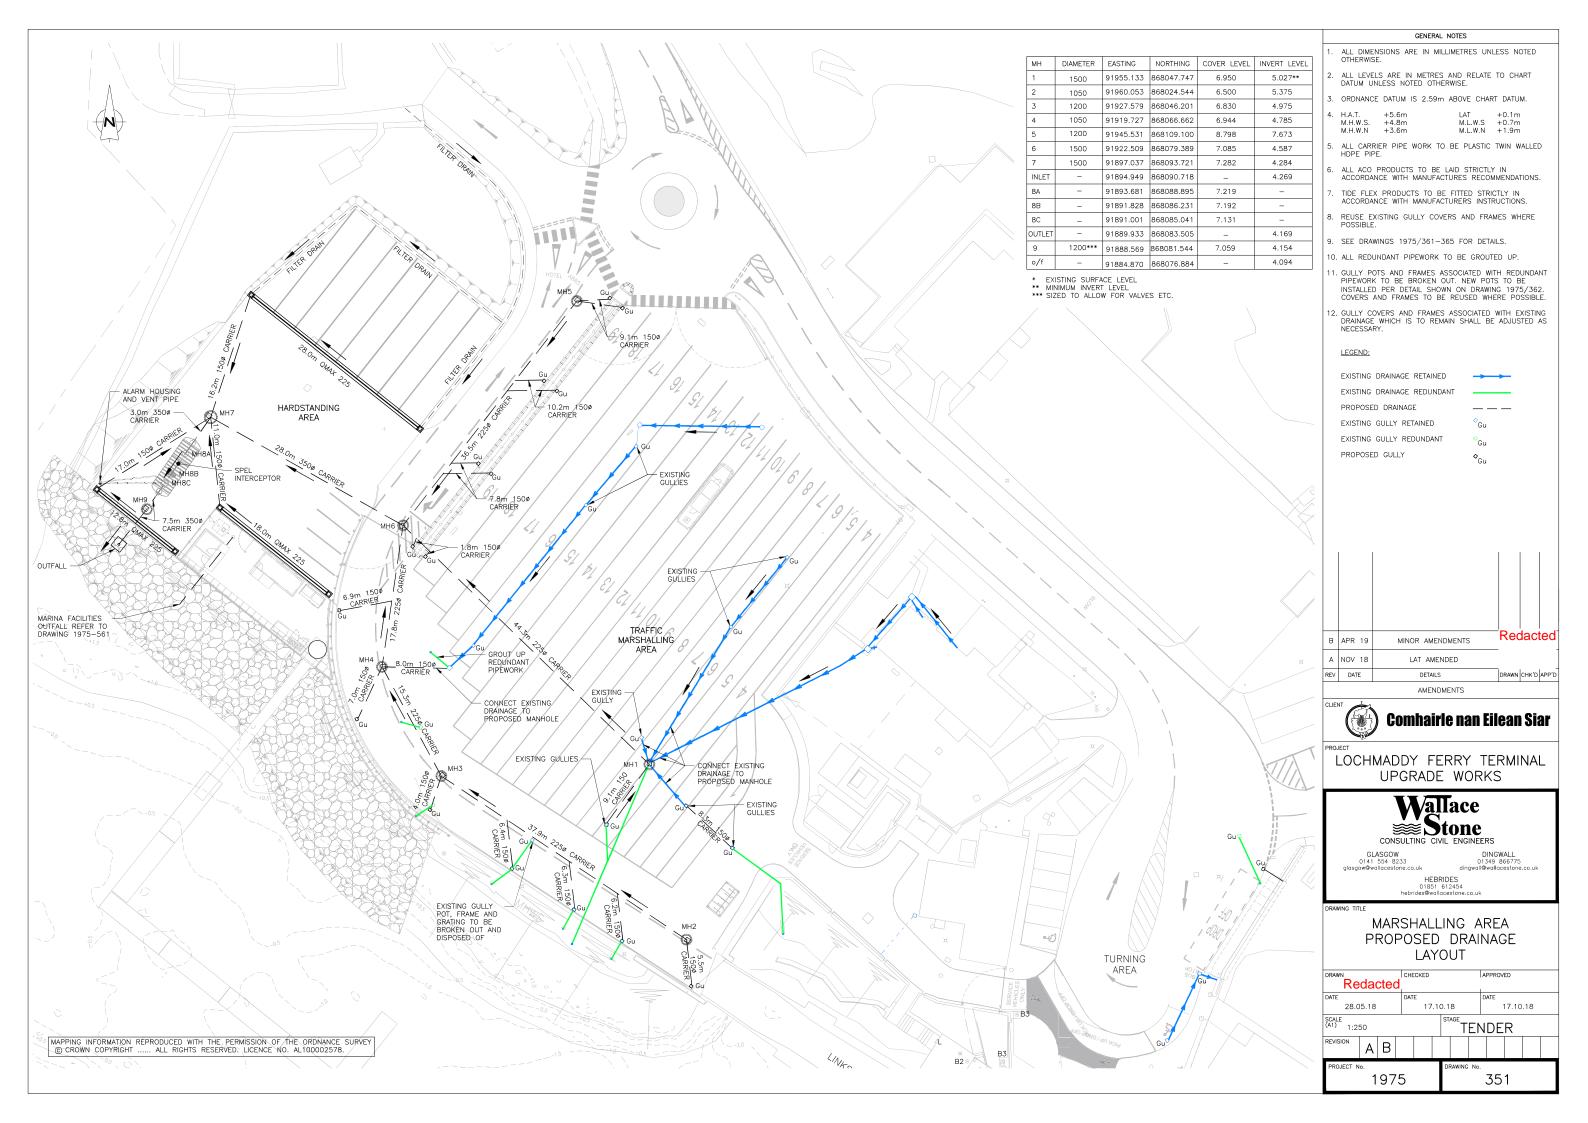

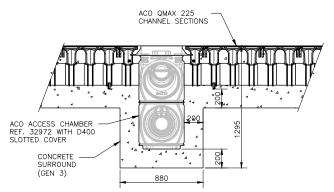
# SECTION THROUGH MID RODDING POINT/CATCHPIT SCALE 1:20




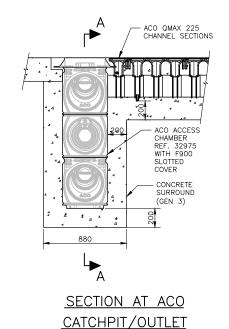

SCALE 1:20

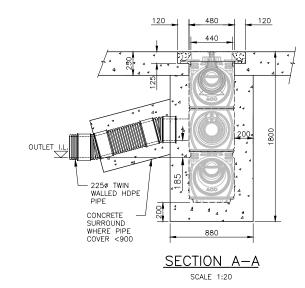



ACO QMAX 225 CHANNEL AND OUTLET

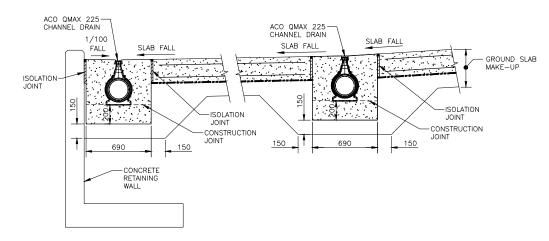


TYPICAL SECTION THROUGH QMAX 225

SCALE 1:20

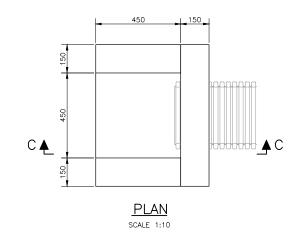

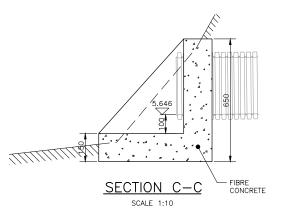

SWALE OUTFALL HEADWALL

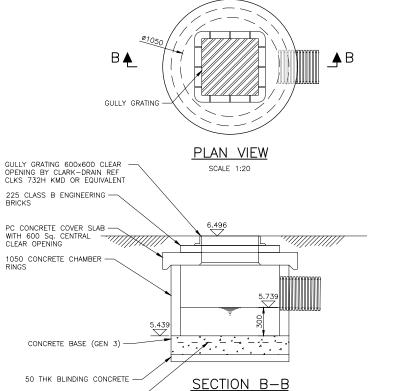


SWALE CATCHPIT DETAILS

SCALE 1:20

A393 MESH REINFORCEMENT

#### GENERAL NOTES

- ALL LEVELS ARE IN METRES AND RELATE TO CHART DATUM UNLESS NOTED OTHERWISE.
- ALL DIMENSIONS ARE IN MILLIMETRES UNLESS NOTED OTHERWISE.
- 3. REFER TO DRAWING 1975/351 FOR THE DRAINAGE LAYOUT.
- 4. REFER TO DRAWING 1975/362-365 FOR ADDITIONAL DRAINAGE DETAILS.
- 5. COVERS TO BE INSTALLED STRICTLY PER MANUFACTURER'S RECOMMENDATIONS/INSTRUCTIONS. REBATES TO BE FILLED WITH 40/50 CONCRETE, 10mm COARSE AGGREGATE.
- D400 GULLY COVERS BEDDED ON 25mm THICK MORTAR BED.

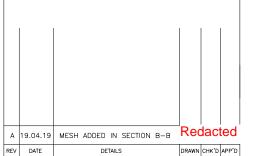

AMENDMENTS




LOCHMADDY FERRY TERMINAL
UPGRADE WORKS





AWING TITLE

DRAINAGE DETAILS (SHEET 1 OF 3)

DRAWN			CHE	CKED					APPROVED				
Redacted													
DATE			DAT	E			DATE						
JUL	′ 20′	18		17	.10	0.18 17.10.1					.18		
SCALE (A1) AS	SHOV	VN				TENDER							
REVISION	Α												
PROJECT N		DRAWING No.											
1075						361							

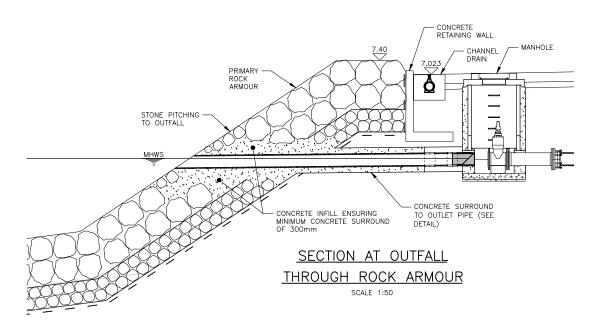

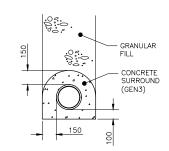


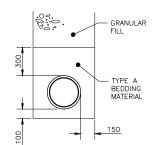

## PIPE BEDDING DETAIL CONCRETE SURROUND


SCALE 1:20

PIPE BEDDING DETAIL GRANULAR SURROUND

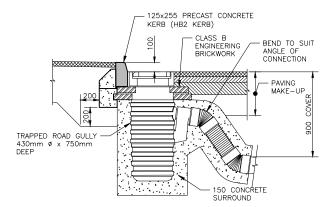


TYPICAL GULLY DETAIL

SCALE 1:20

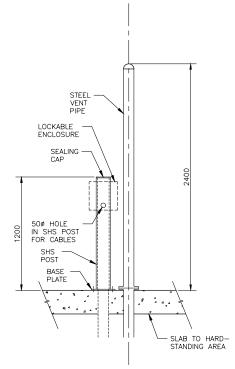

# ELEVATION ON ALARM BOX PILLAR AND STEEL 2.4m HIGH VENT PIPE

SCALE 1:20

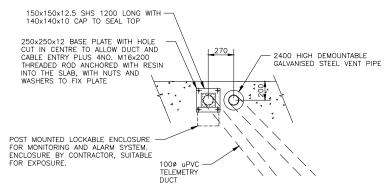

PLAN ON ALARM BOX PILLAR AND STEEL 2.4m HIGH VENT PIPE

SCALE 1:20

### GENERAL NOTES

- 1. ALL LEVELS ARE IN METRES AND RELATE TO CHART DATUM UNLESS NOTED OTHERWISE.
- 2. ALL DIMENSIONS ARE IN MILLIMETRES UNLESS NOTED OTHERWISE.
- REFER TO DRAWING 1975/351 FOR DRAINAGE LAYOUT AND INVERT LEVELS.
- 4. REFER TO DRAWING 1975/361 AND 363-365 FOR ADDITIONAL DRAINAGE DETAILS.
- COVERS TO BE INSTALLED STRICTLY PER MANUFACTURER'S RECOMMENDATIONS/INSTRUCTIONS. REBATES TO BE FILLED WITH 40/50 CONCRETE, 10mm COARSE AGGREGATE.
- 6. D400 GULLY COVERS BEDDED ON 25mm THICK MORTAR BED.



AMENDMENTS



KOJECT LOCHMADDY FERRY TERMINAL UPGRADE WORKS



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HEBRIDES 01851 612454 hebrides@wallacestone.co.uk

DRAWING TITLE

DRAINAGE DETAILS (SHEET 2 OF 3)

				CKED			APPROVED				
Re	dac	ted									
DATE	DATE DAT						1	DATE			
JUL'	JULY 2018			17	.10.	18		17.10.18			
SCALE (A1) AS	SHOV	WN			9	TENDER					
REVISION											
PROJECT No.						DRAWING No.					
1975					ı	362					

